


SYRACUSE, UT 84075

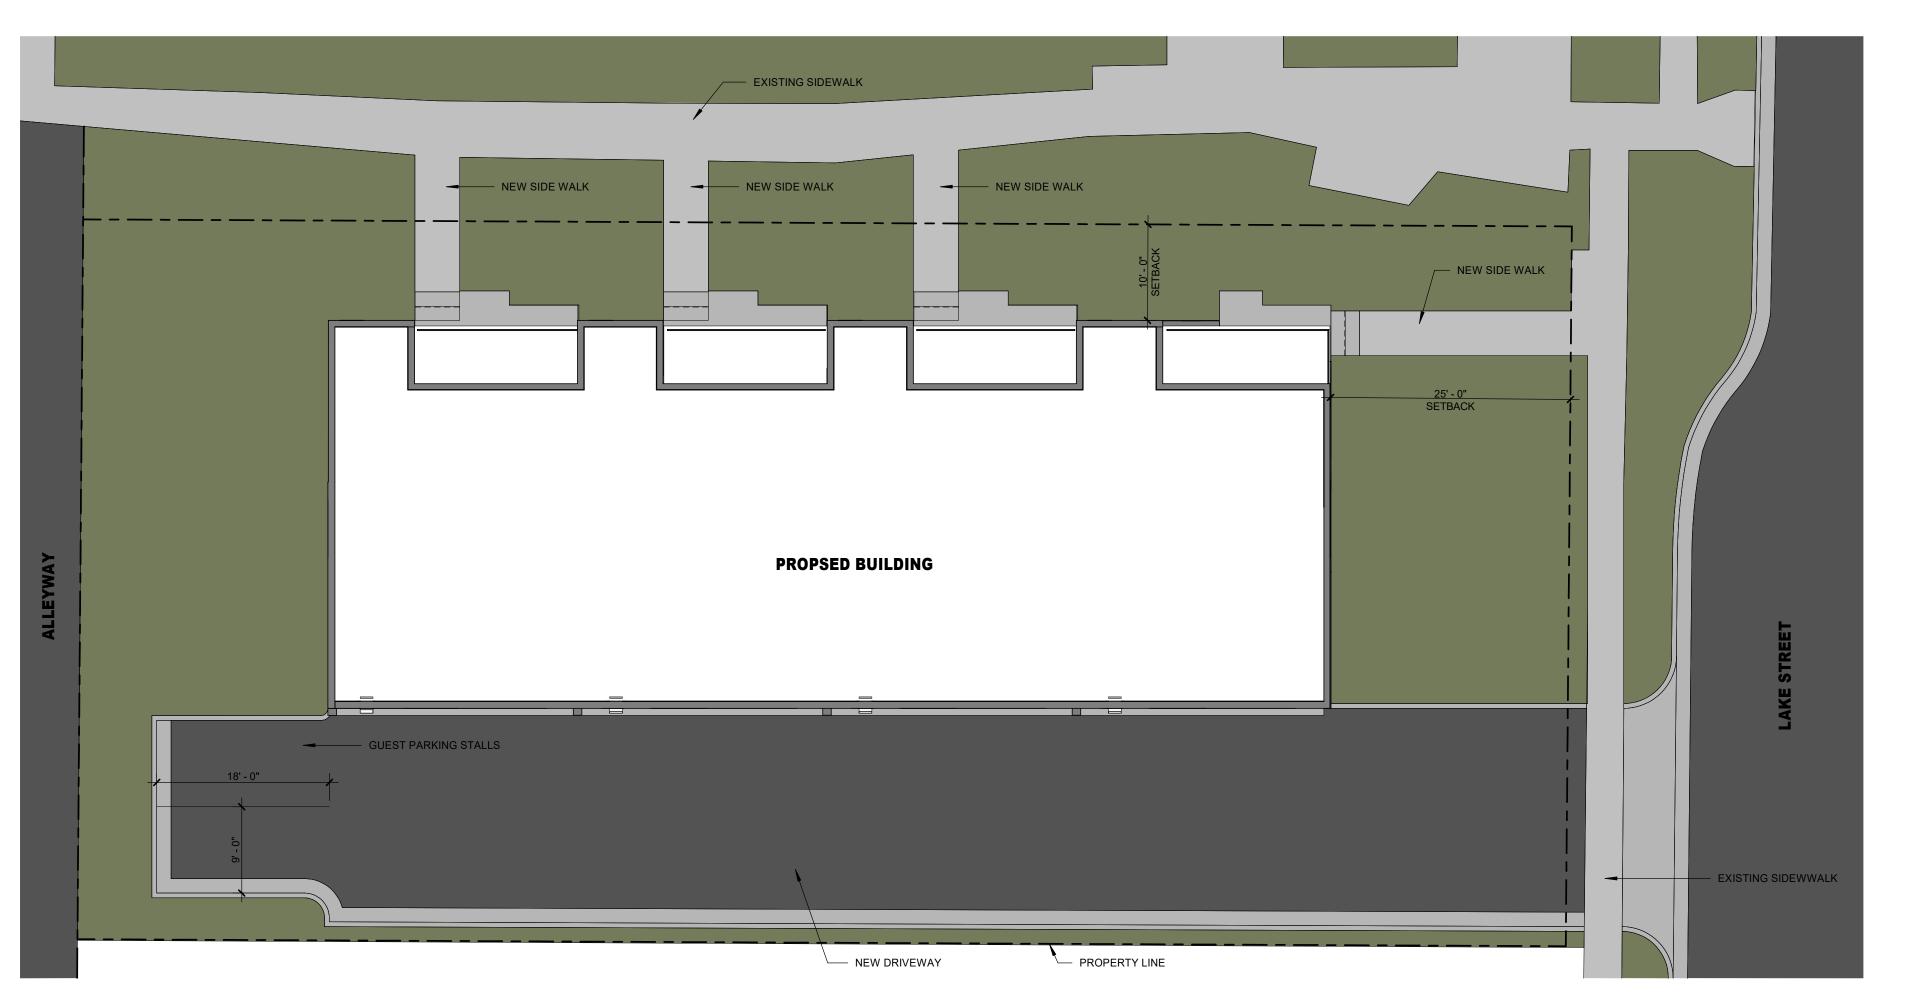



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REVISION
NO. DESCRIPTION DATE

DATE **02/10/22**

ISSUE

SHEET TITLE
SITE PLAN

SHEET NO.

A1.0

FLOOR PLAN KEYED NOTES

- TACTILE SIGN STATING EXIT AND COMPLYING WITH ICC A117.1 IS TO BE PROVIDED ADJACENT TO EACH DOOR TO AN EGRESS STAIRWAY (IBC 1011.3). REFER TO 04/A3.30.
- FLOOR LEVEL IDENTIFICATION SIGNS IN TACTILE CHARACTRERS COMPLYING WITH ICC A117.1 SHALL BE LOCATED AT EACH FLOOR LEVEL LANDING ADJACENT TO THE DOOR LEADING TO THE CORRIDOR, (IBC 1022.8.1). REFER TO 04/A3.30.
- SEMI-RECESSED FIRE EXTINGUISHER CABINET, SEE DETAIL 01/A3.01. REFER TO GENERAL FIRE NOTES ON SHEETS A0.02 AND A0.03 FOR EXTINGUISHER REQUIREMENTS.
- SURFACE MOUNTED FIRE EXTINGUISHER, REFER TO GENERAL NOTES ON SHEETS A0.02 AND A0.03 FOR EXTINGUIHSER REQUIRMENTS.
- PROVIDE A TWO-WAY COMMUNICATION SYSTEM AT EACH LEVEL ADJACENT TO THE ELEVTOR DOOR, PER IBC 1009.8, 1009.8.1 AND 1009.8.2.
- 06 ACCESS POINT.

FLOOR PLAN GENERAL NOTES

- 1. ALL DIMENSIONS ARE TO EXTERIOR FINISH OF WOOD SHEATHING AND/OR GYPSUM BOARD U.N.O.
 2. REFER TO SHEET A3.10 TO A3.15 FOR ENLARGED UNIT TYPE PLANS
 - REFER TO SHEET A3.10 TO A3.15 FOR ENLARGED UNIT TYPE PLAI REFER TO SHEET A5.10 FOR DOOR AND WINDOW TYPES & SCHEDULES ALL BATHROOMS ON THE MAIN LEVEL SHALL BE ADAPTABLE, GENERAL CONTRACTOR SHALL VERIFY THAT ALL FIXTURE LOCATIONS HAVE SOLID BLOCKING AND CLEAR FLOOR SPACES
- SHALL MEET THE MINIMUM REQUIREMENTS OF THE 2009 EDITION OF ICC/ANSI 117.1 AND THE REQUIREMENTS OF SPECIFICATION A BATHROOM OF THE FAIR HOUSING ACT DESIGN MANUAL.

 5. ALL ENTRANCES TO UNITS SHALL BE ON AN ACCESSIBLE ROUTE AND PROVIDE DISABLED ACCESS TO THE UNITS. FLOOR LEVEL OUTSIDE DOORWAYS SHALL BE NO MORE THAN 1/2" BELOW INSIDE
- ALL ENTRANCES TO UNITS SHALL BE ON AN ACCESSIBLE ROUTE AND PROVIDE DISABLED ACCESS TO THE UNITS. FLOOR LEVEL OUTSIDE DOORWAYS SHALL BE NO MORE THAN 1/2" BELOW INSIDE FLOOR LEVEL AND SHALL NOT SLOPE MORE THAN 1/8" PER FOOT.
 ALL LEVEL ENTRY DOORS SHALL BE 36" WIDE AND HAVE LEVER
- ALL LEVEL ENTRY DOORS SHALL BE 36" WIDE AND HAVE LEVER
 TYPE LATCHES AND HAVE THRESHOLDS NO HIGHER THAN 1/2"
 WHICH ARE BEVEALED WITH A SLOPE NO GREATER THAN 1/2"
 CLEAR WIDTH OF AN ACCESSIBLE ROUTE SHALL BE 36" MIN.
 EXCEPT AT DOORS CLEAR WIDTH OF THE ACCESSIBLE ROUTE WITH
- TURNS AROUND AN OBSTRUCTION LESS THAN 48" WIDE SHALL
 HAVE A CLEAR SPACE OF 42" X 48"

 ELECTRICAL SWITCHES, OUTLETS, THEMOSTATS AND OTHER
 ENVIRONMENTAL CONTROLS SHALL HAVE NO OPERABLE DARTS
- ELECTRICAL SWITCHES, OUTLETS, THEMOSTATS AND OTHER ENVIRONMENTAL CONTROLS SHALL HAVE NO OPERABLE PARTS WHICH ARE HIGHER THAN 48" NOR LESS THAN 15" AFF.

 ALL UNITS ARE TO BE PROVIDED WITH SOLID BLOCKING BETWEEN STUDS IN THE BATHROOM WALLS BEHIND THE TOILET AND AROUND THE TUB AND BETWEEN THE WALLS & THE BACK SURFACE OF THE
- OF GRAB BARS (POSSIBLE FUTURE GRAB BAR AR THE SIDE OF THE TOILET WOULD BE EITHER A WALL-TO-FLOOR TYPD OR FOLD DOWN TYPE.) SEE ENLARGED BATHROOMS PLANS ON SHEET A3.12

 10. A CLEAR FLOOR SPACE AT LEAST 30" X 48" THAT ALLOWS EITHER A FORWARD OR A PARALLEL APPROACH BY A PERSON IN A WHEELCHAIR SAHLL BE PROVIDED AT ALL APPLICANCES IN THE KITCHEN, INCLUDING THE RANGE/COOKTOP, OVEN, REFRIGERATOR, DISHWASHER AND/OR COMPACTOR. THE LOCATION OF THE CONTROLS FOR RANGE/COOKTOPS SHALL NOT REQUIRE REACHING


TUB/SHOWER SPLASH FOR THE POSSIBLE FUTURE INSTALLATION

- CONTROLS FOR RANGE/COOKTOPS SHALL NOT REQUIRE REACHING ACROSS BURNERS.

 1. THE FINISHED FLOOR IS TO CONTINUE AND THE CABINETRY AND WALL SURFACES FINISHED UNDER CABINETS WITH REMOVEABLE DOORS FOR HANDICAP FORWARD APPROACH.
- PROVIDE SOLID 2X FIRE BLOCKING AT ALL CEILING AND FLOOR LEVELS, TOPS AND BOTTOMS OF STAIRWAYS, AND AT DROPPED CEILING LOCATIONS.
 SEE CIVIL AND LANDSCAPE DRAWINGS FOR CONTINUATION OF
- CEILING LOCATIONS.

 13. SEE CIVIL AND LANDSCAPE DRAWINGS FOR CONTINUATION OF SIDEWALK MAXIMUM 2% SLOPE AT EXTERIOR DOOR LANDINGS IN THE DIRECTION OF TRAVEL.
- 14. REFER TO SHEET A5.06 FOR WINDOW TYPES
 15. REFER TO SHEET A5.01 FOR INTERIOR GLAZED ALUMINUM WALL SYSTEM ELEVATIONS. REFER TO SHEET A3.05 FOR MANUFACTURERS INFORMATION AND SPECIFICATIONS.
- 16. REFER TO MECHANICAL, PLUMBING AND ELECTRICAL DRAWINGS FOR ALL MECHANICAL ROOM EQUIPMENT LAYOUTS AND REQUIREMENTS.
- 17. REFER TO 01/A3.01 FOR TYPCIAL 1 HOUR SEMI RECESSED FIRE CABINET DETAIL
 18. REFER TO 02/A3.01 FOR TYPICAL 1 HOUR RATED PLUMBING
- LAUNDRY BOX DETAIL

 19. REFER TO 03/A3.01 FOR TYPICAL 1 HOUR RATED SHOWER VALVE DETAIL.
- 20. MAILBOXES TO BE PLACED PER USPS RECOMMENDATIONS, NO LOWER THAN 15" AFF. ALL TYPE A UNIT MAIL SLOTSMUST BE PLACED NO LOWER THAN 15" AFF AND NO HIGHER THAN 48" AFF.

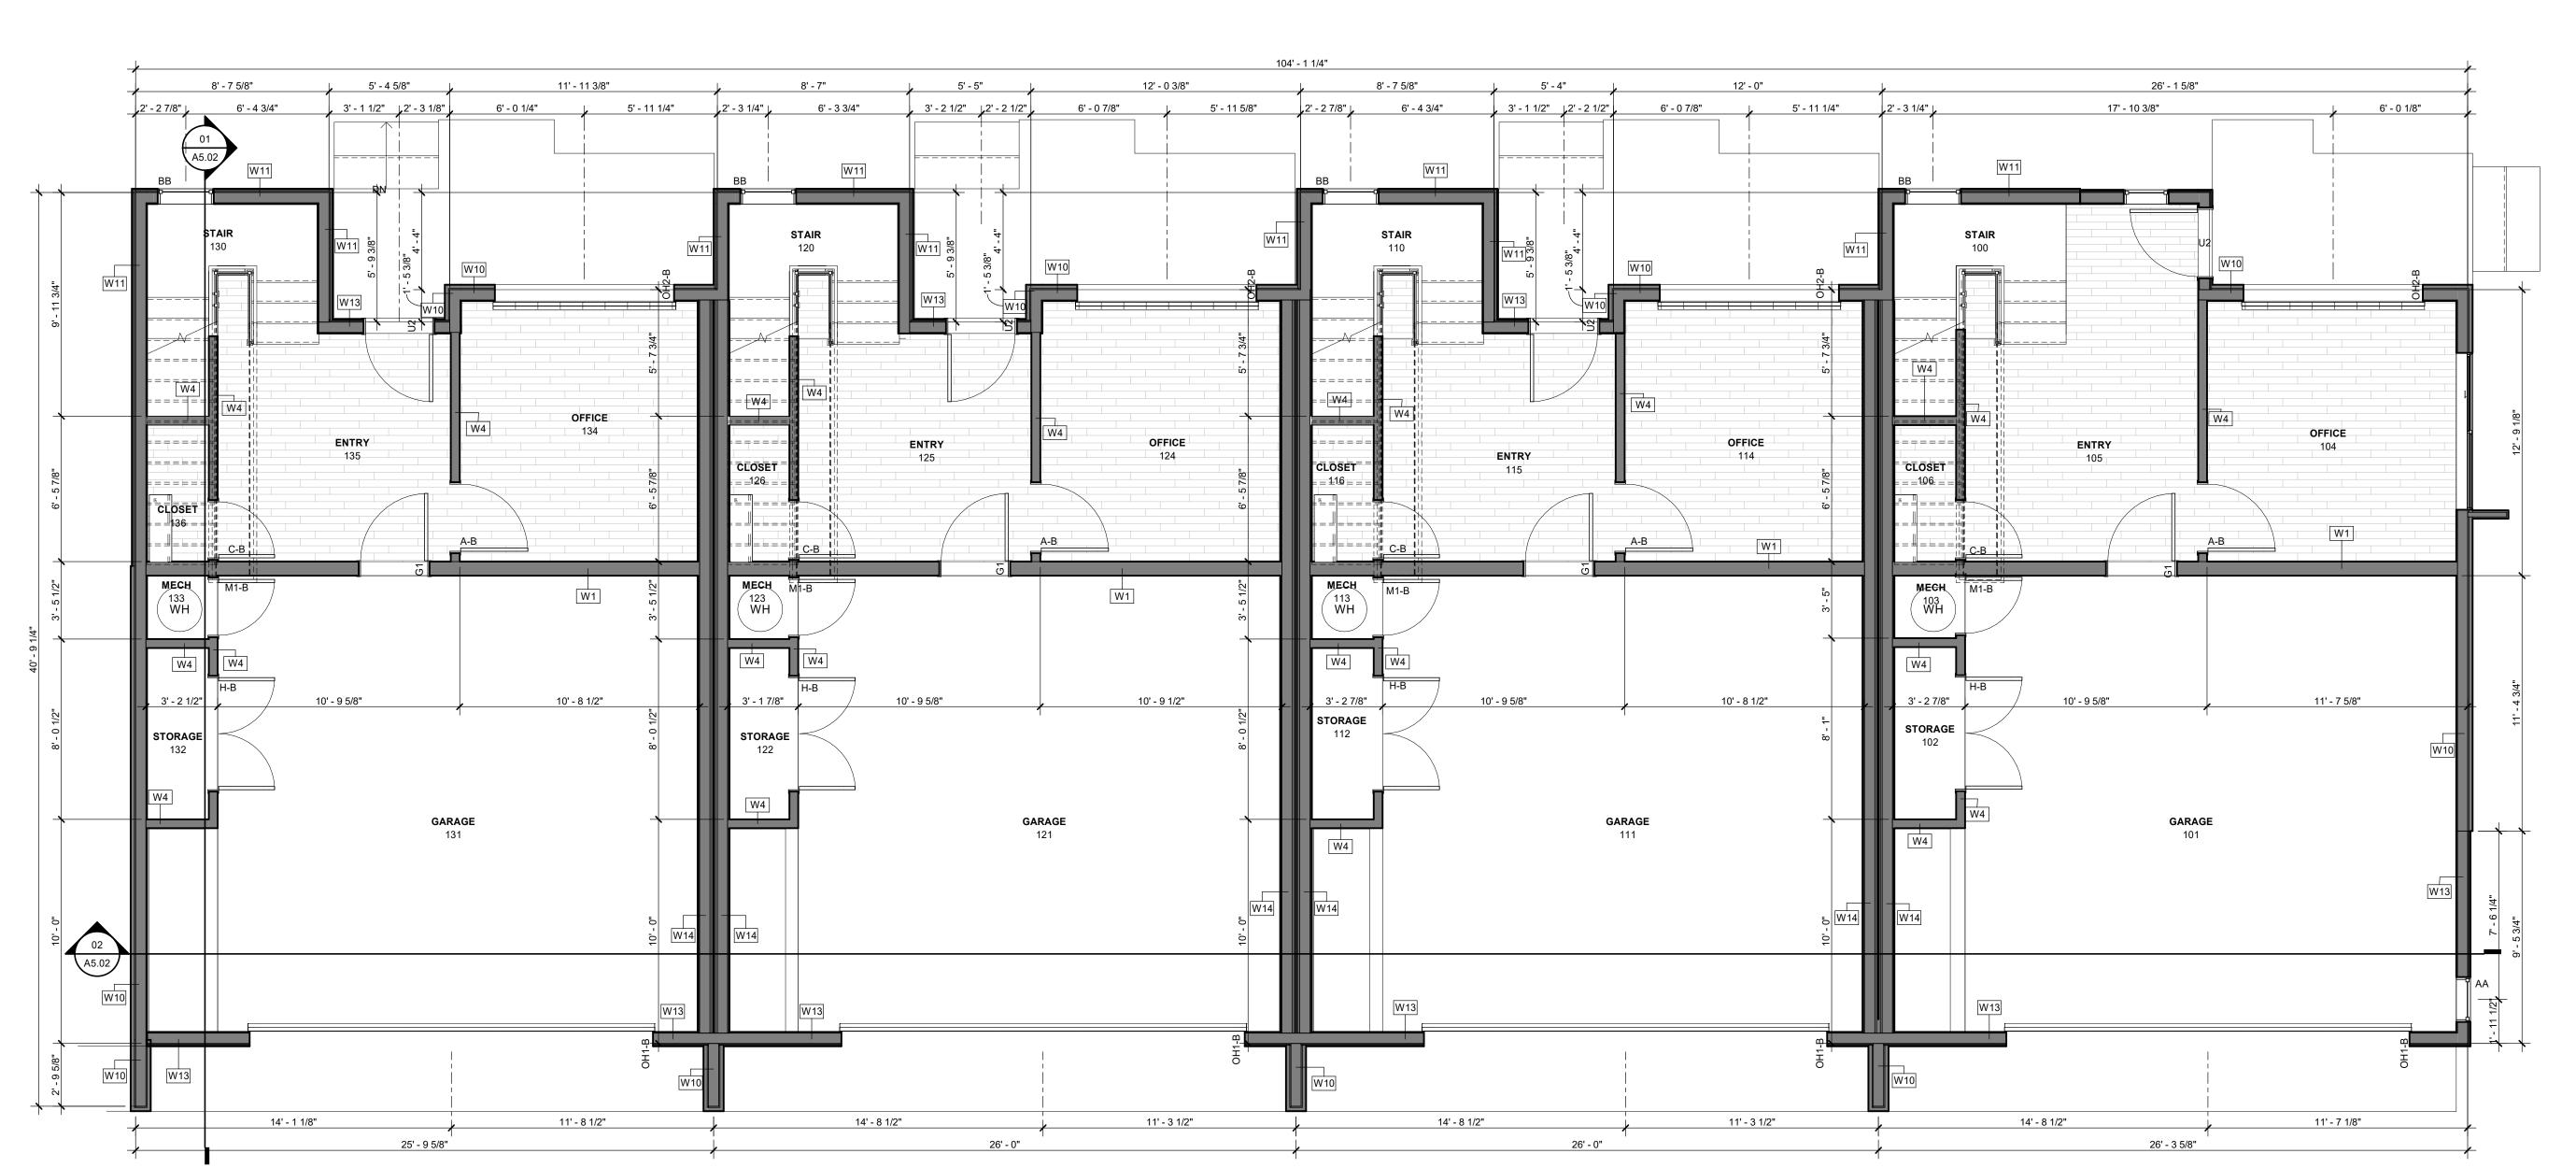

MAIN LEVEL FLOOR PLAN

1/4" = 1'-0"

ARCHITECT JSF LLC

3149 SOUTH 550 WEST SYRACUSE, UT 84075

> REPUBLIC 2225 SOUTH 700 EAST

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DATE **01/17/2022**

MAIN LEVEL
FLOOR PLAN

SHEET NO.

A2.01

FLOOR PLAN KEYED NOTES

- TACTILE SIGN STATING EXIT AND COMPLYING WITH ICC A117.1 IS TO BE PROVIDED ADJACENT TO EACH DOOR TO AN EGRESS STAIRWAY (IBC 1011.3). REFER TO 04/A3.30.
- FLOOR LEVEL IDENTIFICATION SIGNS IN TACTILE CHARACTRERS COMPLYING WITH ICC A117.1 SHALL BE LOCATED AT EACH FLOOR LEVEL LANDING ADJACENT TO THE DOOR LEADING TO THE CORRIDOR, (IBC 1022.8.1). REFER TO
- SEMI-RECESSED FIRE EXTINGUISHER CABINET, SEE DETAIL 01/A3.01. REFER TO GENERAL FIRE NOTES ON SHEETS A0.02 AND A0.03 FOR EXTINGUISHER REQUIREMENTS.
- SURFACE MOUNTED FIRE EXTINGUISHER, REFER TO GENERAL NOTES ON SHEETS A0.02 AND A0.03 FOR EXTINGUIHSER REQUIRMENTS
- PROVIDE A TWO-WAY COMMUNICATION SYSTEM AT EACH LEVEL ADJACENT TO THE ELEVTOR DOOR, PER IBC 1009.8, 1009.8.1 AND 1009.8.2.
- ACCESS POINT.


FLOOR PLAN GENERAL NOTES

- - ALL DIMENSIONS ARE TO EXTERIOR FINISH OF WOOD SHEATHING AND/OR GYPSUM BOARD U.N.O.

 REFER TO SHEET A3.10 TO A3.15 FOR ENLARGED UNIT TYPE PLANS REFER TO SHEET A5.10 FOR DOOR AND WINDOW TYPES & SCHEDULES ALL BATHROOMS ON THE MAIN LEVEL SHALL BE ADAPTABLE,
 - GENERAL CONTRACTOR SHALL VERIFY THAT ALL FIXTURE LOCATIONS HAVE SOLID BLOCKING AND CLEAR FLOOR SPACES SHALL MEET THE MINIMUM REQUIREMENTS OF THE 2009 EDITION OF ICC/ANSI 117.1 AND THE REQUIREMENTS OF SPECIFICATION A BATHROOM OF THE FAIR HOUSING ACT DESIGN MANUAL.
 - ALL ENTRANCES TO UNITS SHALL BE ON AN ACCESSIBLE ROUTE AND PROVIDE DISABLED ACCESS TO THE UNITS. FLOOR LEVEL OUTSIDE DOORWAYS SHALL BE NO MORE THAN 1/2" BELOW INSIDE FLOOR LEVEL AND SHALL NOT SLOPE MORE THAN 1/8" PER FOOT.
 - ALL LEVEL ENTRY DOORS SHALL BE 36" WIDE AND HAVE LEVER TYPE LATCHES AND HAVE THRESHOLDS NO HIGHER THAN 1/2" WHICH ARE BEVEALED WITH A SLOPE NO GREATER THAN 1/2" CLEAR WIDTH OF AN ACCESSIBLE ROUTE SHALL BE 36" MIN.
 - EXCEPT AT DOORS CLEAR WIDTH OF THE ACCESSIBLE ROUTE WITH TURNS AROUND AN OBSTRUCTION LESS THAN 48" WIDE SHALL HAVE A CLEAR SPACE OF 42" X 48"
 - ELECTRICAL SWITCHES, OUTLETS, THEMOSTATS AND OTHER ENVIRONMENTAL CONTROLS SHALL HAVE NO OPERABLE PARTS WHICH ARE HIGHER THAN 48" NOR LESS THAN 15" AFF. ALL UNITS ARE TO BE PROVIDED WITH SOLID BLOCKING BETWEEN STUDS IN THE BATHROOM WALLS BEHIND THE TOILET AND AROUND
 - TUB/SHOWER SPLASH FOR THE POSSIBLE FUTURE INSTALLATION OF GRAB BARS (POSSIBLE FUTURE GRAB BAR AR THE SIDE OF THE TOILET WOULD BE EITHER A WALL-TO-FLOOR TYPD OR FOLD DOWN TYPE.) SEE ENLARGED BATHROOMS PLANS ON SHEET A3.12 10. A CLEAR FLOOR SPACE AT LEAST 30" X 48" THAT ALLOWS EITHER A FORWARD OR A PARALLEL APPROACH BY A PERSON IN A WHEELCHAIR SAHLL BE PROVIDED AT ALL APPLICANCES IN THE KITCHEN, INCLUDING THE RANGE/COOKTOP, OVEN, REFRIGERATOR,

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- DISHWASHER AND/OR COMPACTOR. THE LOCATION OF THE CONTROLS FOR RANGE/COOKTOPS SHALL NOT REQUIRE REACHING ACROSS BURNERS. . THE FINISHED FLOOR IS TO CONTINUE AND THE CABINETRY AND WALL SURFACES FINISHED UNDER CABINETS WITH REMOVEABLE
- DOORS FOR HANDICAP FORWARD APPROACH. 2. PROVIDE SOLID 2X FIRE BLOCKING AT ALL CEILING AND FLOOR LEVELS, TOPS AND BOTTOMS OF STAIRWAYS, AND AT DROPPED
- CEILING LOCATIONS. 13. SEE CIVIL AND LANDSCAPE DRAWINGS FOR CONTINUATION OF SIDEWALK MAXIMUM 2% SLOPE AT EXTERIOR DOOR LANDINGS IN THE DIRECTION OF TRAVEL.
- 4. REFER TO SHEET A5.06 FOR WINDOW TYPES 15. REFER TO SHEET A5.01 FOR INTERIOR GLAZED ALUMINUM WALL SYSTEM ELEVATIONS. REFER TO SHEET A3.05 FOR
- MANUFACTURERS INFORMATION AND SPECIFICATIONS. 6. REFER TO MECHANICAL, PLUMBING AND ELECTRICAL DRAWINGS FOR ALL MECHANICAL ROOM EQUIPMENT LAYOUTS AND
- REQUIREMENTS. 7. REFER TO 01/A3.01 FOR TYPCIAL 1 HOUR SEMI RECESSED FIRE
- 18. REFER TO 02/A3.01 FOR TYPICAL 1 HOUR RATED PLUMBING LAUNDRY BOX DETAIL 9. REFER TO 03/A3.01 FOR TYPICAL 1 HOUR RATED SHOWER VALVE
- 20. MAILBOXES TO BE PLACED PER USPS RECOMMENDATIONS, NO LOWER THAN 15" AFF. ALL TYPE A UNIT MAIL SLOTSMUST BE

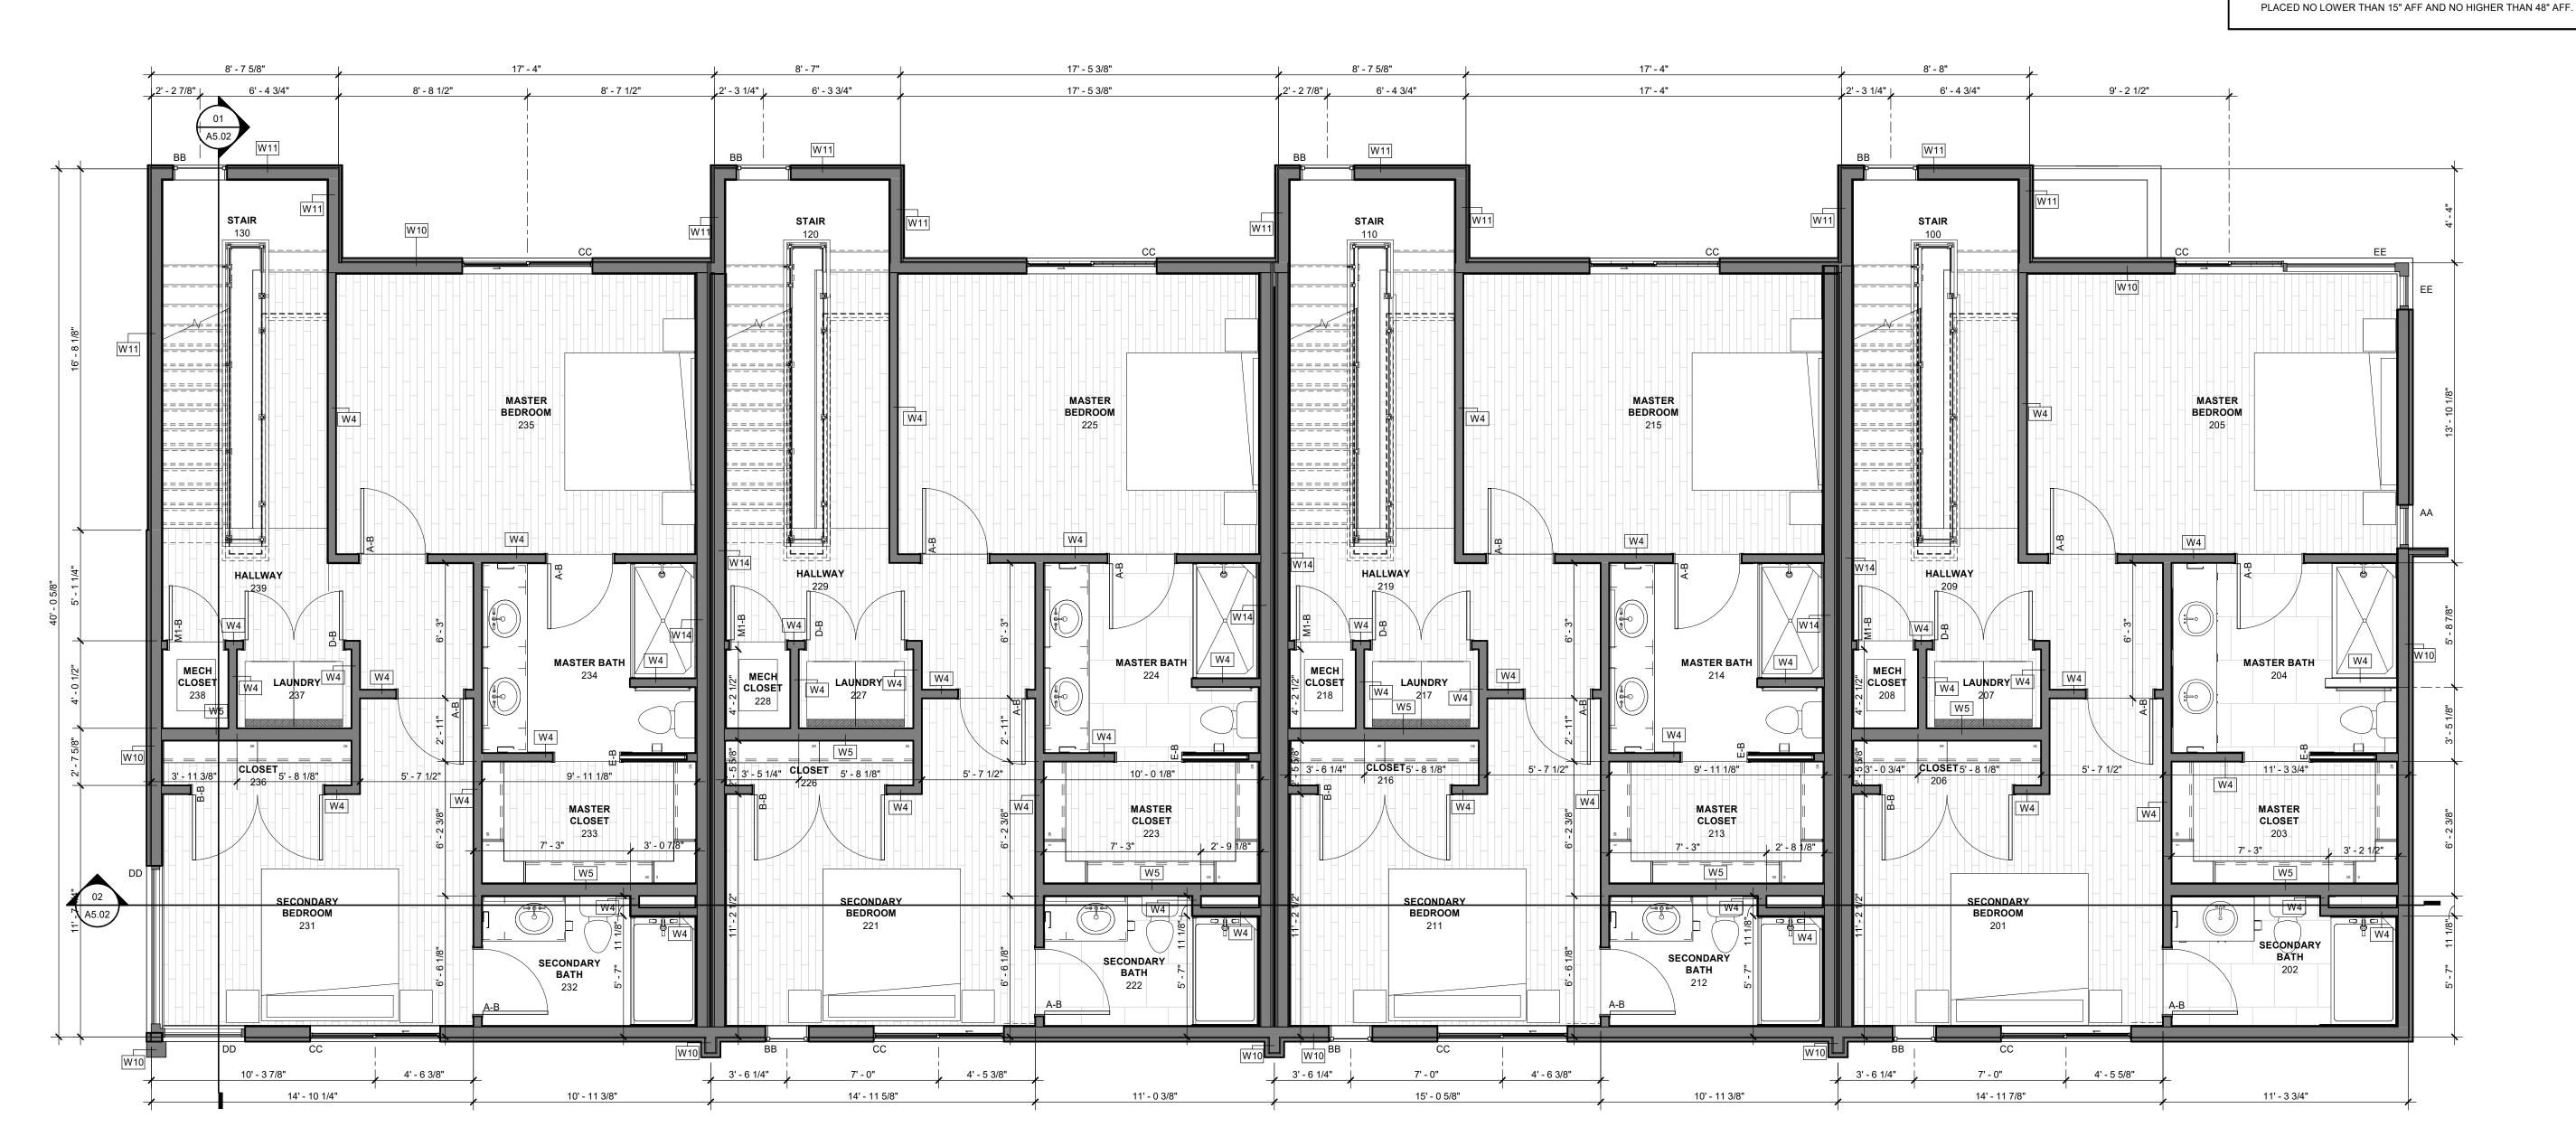

N 01 SECOND LEVEL FLOOR PLAN
1/4" = 1'-0"

SUGAR REPU 2225 SOUTH SALT LAKE CH

ARCHITECT

3149 SOUTH 550 WEST

SYRACUSE, UT 84075

JSF LLC

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NO. DESCRIPTION DATE

10/19/2021 ISSUE

SECOND LEVEL FLOOR PLAN

SHEET NO.

A2.02

FLOOR PLAN GENERAL NOTES FLOOR PLAN KEYED NOTES ALL DIMENSIONS ARE TO EXTERIOR FINISH OF WOOD SHEATHING AND/OR GYPSUM BOARD U.N.O. REFER TO SHEET A3.10 TO A3.15 FOR ENLARGED UNIT TYPE PLANS TACTILE SIGN STATING EXIT AND COMPLYING WITH ICC A117.1 IS TO BE PROVIDED ADJACENT TO EACH DOOR TO AN EGRESS STAIRWAY (IBC 1011.3). REFER TO 04/A3.30. REFER TO SHEET A5.10 FOR DOOR AND WINDOW TYPES & FLOOR LEVEL IDENTIFICATION SIGNS IN TACTILE SCHEDULES CHARACTRERS COMPLYING WITH ICC A117.1 SHALL BE ALL BATHROOMS ON THE MAIN LEVEL SHALL BE ADAPTABLE, LOCATED AT EACH FLOOR LEVEL LANDING ADJACENT TO THE GENERAL CONTRACTOR SHALL VERIFY THAT ALL FIXTURE DOOR LEADING TO THE CORRIDOR, (IBC 1022.8.1). REFER TO LOCATIONS HAVE SOLID BLOCKING AND CLEAR FLOOR SPACES SHALL MEET THE MINIMUM REQUIREMENTS OF THE 2009 EDITION OF ICC/ANSI 117.1 AND THE REQUIREMENTS OF SPECIFICATION A SEMI-RECESSED FIRE EXTINGUISHER CABINET, SEE DETAIL BATHROOM OF THE FAIR HOUSING ACT DESIGN MANUAL. 01/A3.01. REFER TO GENERAL FIRE NOTES ON SHEETS A0.02 ALL ENTRANCES TO UNITS SHALL BE ON AN ACCESSIBLE ROUTE AND A0.03 FOR EXTINGUISHER REQUIREMENTS. AND PROVIDE DISABLED ACCESS TO THE UNITS. FLOOR LEVEL OUTSIDE DOORWAYS SHALL BE NO MORE THAN 1/2" BELOW INSIDE SURFACE MOUNTED FIRE EXTINGUISHER, REFER TO GENERAL NOTES ON SHEETS A0.02 AND A0.03 FOR EXTINGUIHSER FLOOR LEVEL AND SHALL NOT SLOPE MORE THAN 1/8" PER FOOT. ALL LEVEL ENTRY DOORS SHALL BE 36" WIDE AND HAVE LEVER TYPE LATCHES AND HAVE THRESHOLDS NO HIGHER THAN 1/2" REQUIRMENTS. WHICH ARE BEVEALED WITH A SLOPE NO GREATER THAN 1/2" PROVIDE A TWO-WAY COMMUNICATION SYSTEM AT EACH LEVEL ADJACENT TO THE ELEVTOR DOOR, PER IBC 1009.8, CLEAR WIDTH OF AN ACCESSIBLE ROUTE SHALL BE 36" MIN. EXCEPT AT DOORS CLEAR WIDTH OF THE ACCESSIBLE ROUTE WITH TURNS AROUND AN OBSTRUCTION LESS THAN 48" WIDE SHALL 1009.8.1 AND 1009.8.2. HAVE A CLEAR SPACE OF 42" X 48" (06) ACCESS POINT. ELECTRICAL SWITCHES, OUTLETS, THEMOSTATS AND OTHER ENVIRONMENTAL CONTROLS SHALL HAVE NO OPERABLE PARTS WHICH ARE HIGHER THAN 48" NOR LESS THAN 15" AFF. ALL UNITS ARE TO BE PROVIDED WITH SOLID BLOCKING BETWEEN STUDS IN THE BATHROOM WALLS BEHIND THE TOILET AND AROUND THE TUB AND BETWEEN THE WALLS & THE BACK SURFACE OF THE

ACROSS BURNERS.

CEILING LOCATIONS.

REQUIREMENTS.

LAUNDRY BOX DETAIL

THE DIRECTION OF TRAVEL.

TUB/SHOWER SPLASH FOR THE POSSIBLE FUTURE INSTALLATION

OF GRAB BARS (POSSIBLE FUTURE GRAB BAR AR THE SIDE OF THE

10. A CLEAR FLOOR SPACE AT LEAST 30" X 48" THAT ALLOWS EITHER A

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2. PROVIDE SOLID 2X FIRE BLOCKING AT ALL CEILING AND FLOOR LEVELS, TOPS AND BOTTOMS OF STAIRWAYS, AND AT DROPPED

13. SEE CIVIL AND LANDSCAPE DRAWINGS FOR CONTINUATION OF SIDEWALK MAXIMUM 2% SLOPE AT EXTERIOR DOOR LANDINGS IN

15. REFER TO SHEET A5.01 FOR INTERIOR GLAZED ALUMINUM WALL SYSTEM ELEVATIONS. REFER TO SHEET A3.05 FOR MANUFACTURERS INFORMATION AND SPECIFICATIONS.
 16. REFER TO MECHANICAL, PLUMBING AND ELECTRICAL DRAWINGS FOR ALL MECHANICAL ROOM EQUIPMENT LAYOUTS AND

7. REFER TO 01/A3.01 FOR TYPCIAL 1 HOUR SEMI RECESSED FIRE


18. REFER TO 02/A3.01 FOR TYPICAL 1 HOUR RATED PLUMBING

FORWARD OR A PARALLEL APPROACH BY A PERSON IN A WHEELCHAIR SAHLL BE PROVIDED AT ALL APPLICANCES IN THE KITCHEN, INCLUDING THE RANGE/COOKTOP, OVEN, REFRIGERATOR, DISHWASHER AND/OR COMPACTOR. THE LOCATION OF THE CONTROLS FOR RANGE/COOKTOPS SHALL NOT REQUIRE REACHING

DOORS FOR HANDICAP FORWARD APPROACH.

14. REFER TO SHEET A5.06 FOR WINDOW TYPES

TOILET WOULD BE EITHER A WALL-TO-FLOOR TYPD OR FOLD DOWN TYPE.) SEE ENLARGED BATHROOMS PLANS ON SHEET A3.12

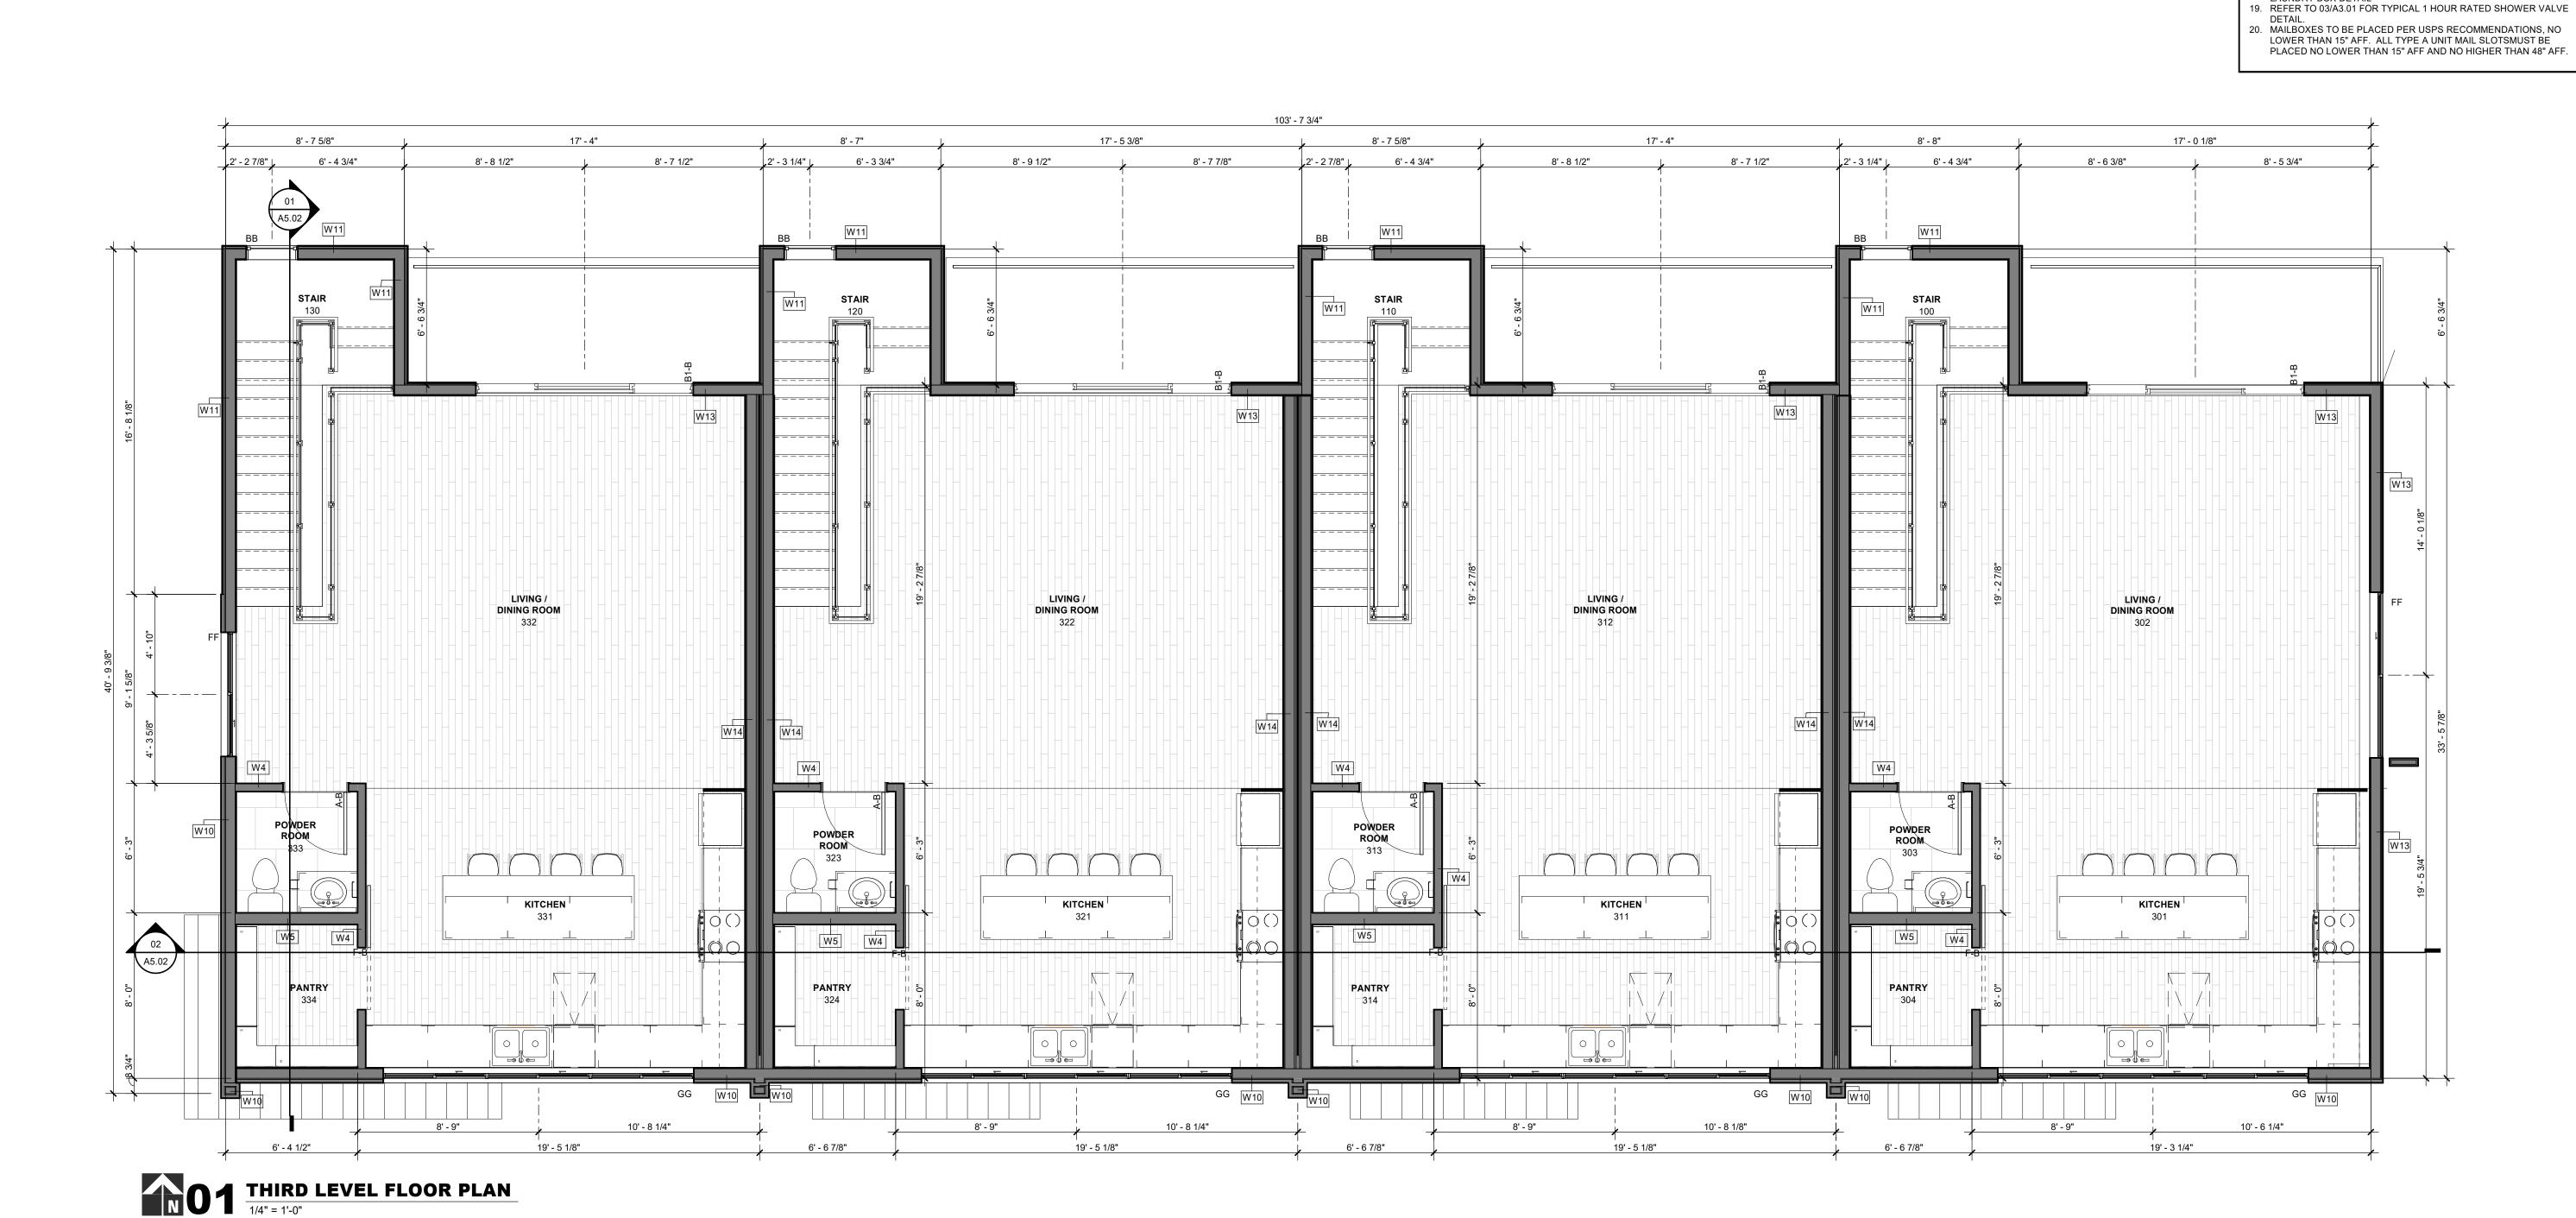

ARCHITECT

JSF LLC 3149 SOUTH 550 WEST SYRACUSE, UT 84075

> HOUSE 3LIC

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SHEET TITLE
THIRD LEVEL
FLOOR PLAN

SHEET NO

ISSUE


A2.03









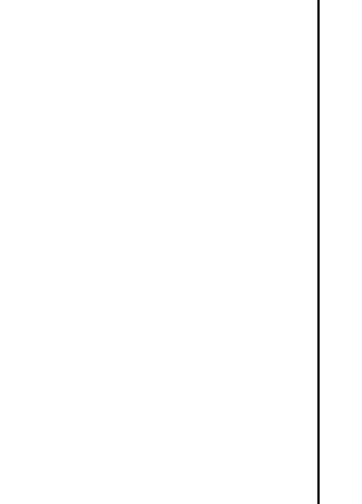

ELEVATION GENERAL NOTES

LOCAITONS

BALCONY

SOFFIT/FASCIA

RAILINGS

TO BE OFOI

AND CONFIGURATIONS

BALCONY GAURDRAIL DETAILS

| ELEVATION FINISH MATERIALS

REFER TO ELECTRICAL PLANS FOR EXTERIOR LIGHTING

SLOPE EXTERIOR FINISH GRADE AWAY FROM PERIMETER OF BUILDING FOR PROPER DRAINAGE, TYP. REFER TO SHEETS A3.50 FOR DOOR TYPES AND SCHEDULES.
REFER TO SHEET A5.06 FOR WINDOW TYPES REFER TO MECHANICAL DRAWINGS FOR GAS METER LOCATIONS

REFER TO ELECTRICAL DRAWINGS FOR ELECTRICAL METER LOCATIONS AND CONFIGURATIONS

ALL EXTERIOR RAILINGS TO BE 42" HIGH, BALLASTERS @ 4 O.C. PER CODE, REFER TO DETAIL 01/A7.03
REFER TO SHEETS A7.10 THRU A7.16 FOR BALCONY ENLARGED PLANS AND DETAILS
REFER TO SHEET A7.11 AND A7.14 FOR TYPICAL EXTERIOR

CULTURED STONE, RUNNING BOND

HORIZONTAL WOOD SIDING
MANUFACTURER: THERMORY
COLOR: BENCHMARK WHITE ASH

MANUFACTURER: INTERSTATE BRICK

COLOR: COAL BLACK (SIGNATURE 200)
MANUFACTURER: MBCI
PRODUCT: FW-120-0 (CONCEALED FASTENING

COLOR: PLATINUM

METAL PANELING

WALL SYSTEM)

SIZE: 1 X 8 T/G (JEM)

GLAZING (GL-01) MANUFACTURER: NBI GLASS TYPE: 1" O.A. CLEAR LOW E SNX 62/27 LOW E

MANUFACTURER: FIRESTONE - UC-501

COLOR: TO BE APPROVED BY ARCHITECT STYLE: FLUSH ALUMINUM PANELS

FINISH: KYNAR 500 / HYLAR 5000 FLUOROCARBON

ARCHITECT

3149 SOUTH 550 WEST SYRACUSE, UT 84075

JSF LLC

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01/17/2022 ISSUE

SHEET TITLE **EXTERIOR ELEVATIONS**

SHEET NO.



 $04 \frac{\text{WEST ELEVATION}}{1/8" = 1'-0"}$ 03 SOUTH ELEVATION

1/8" = 1'-0"